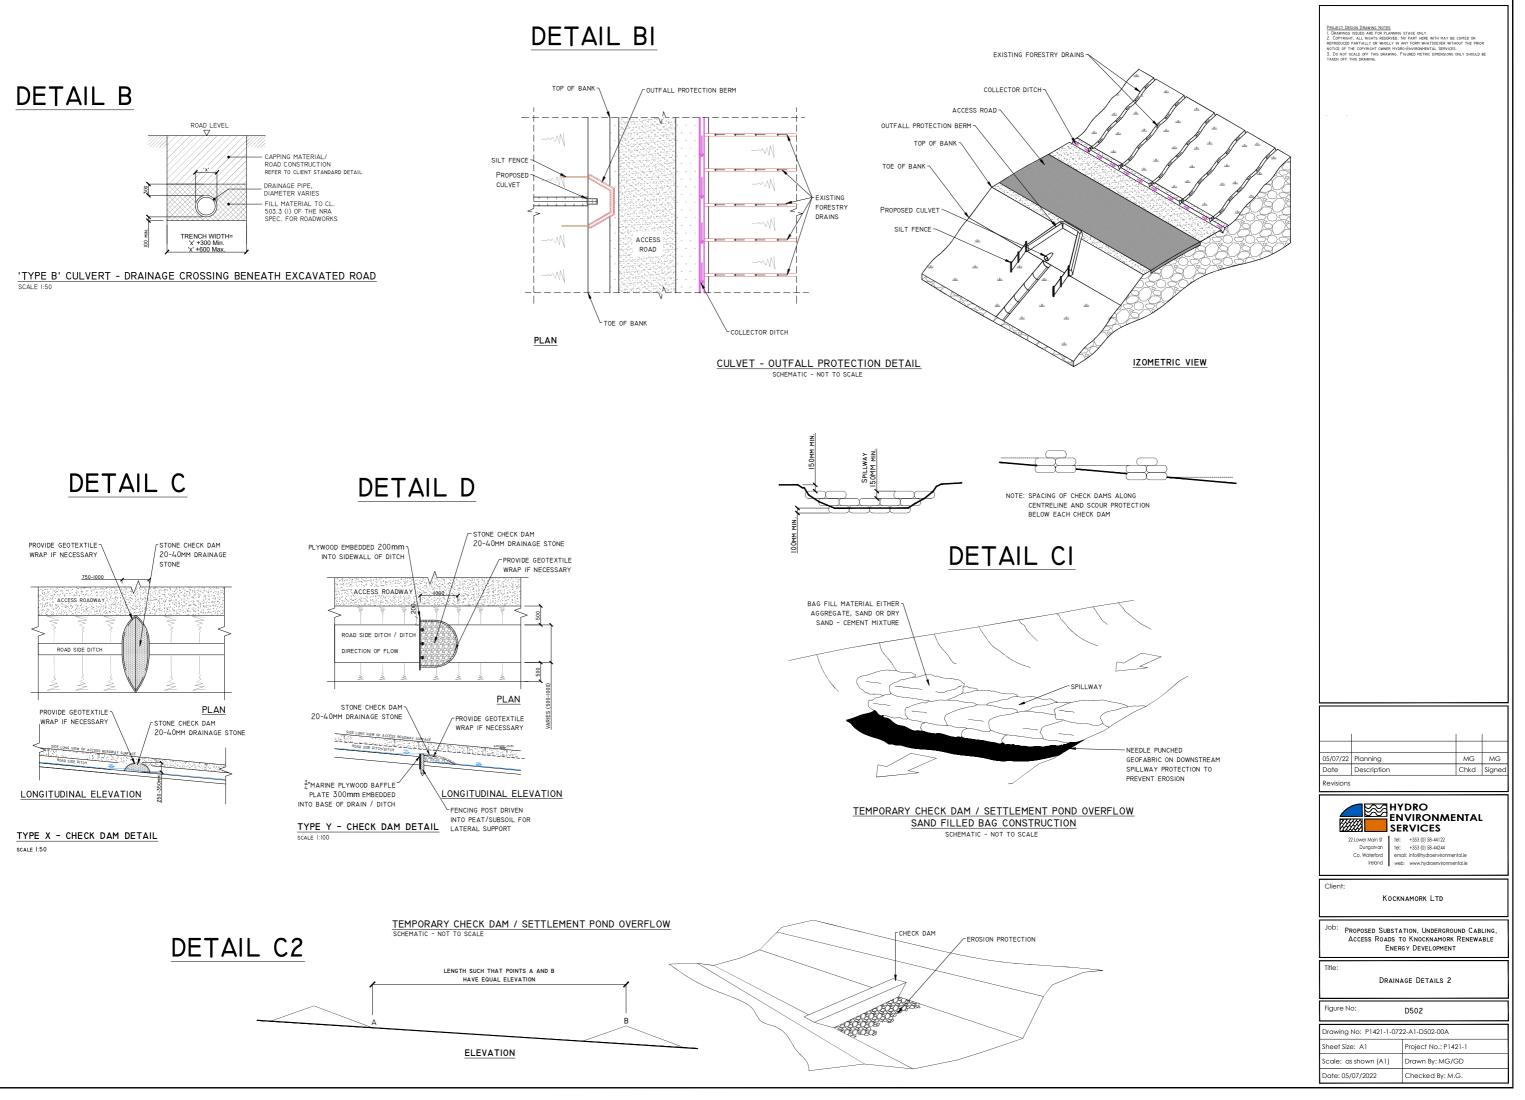
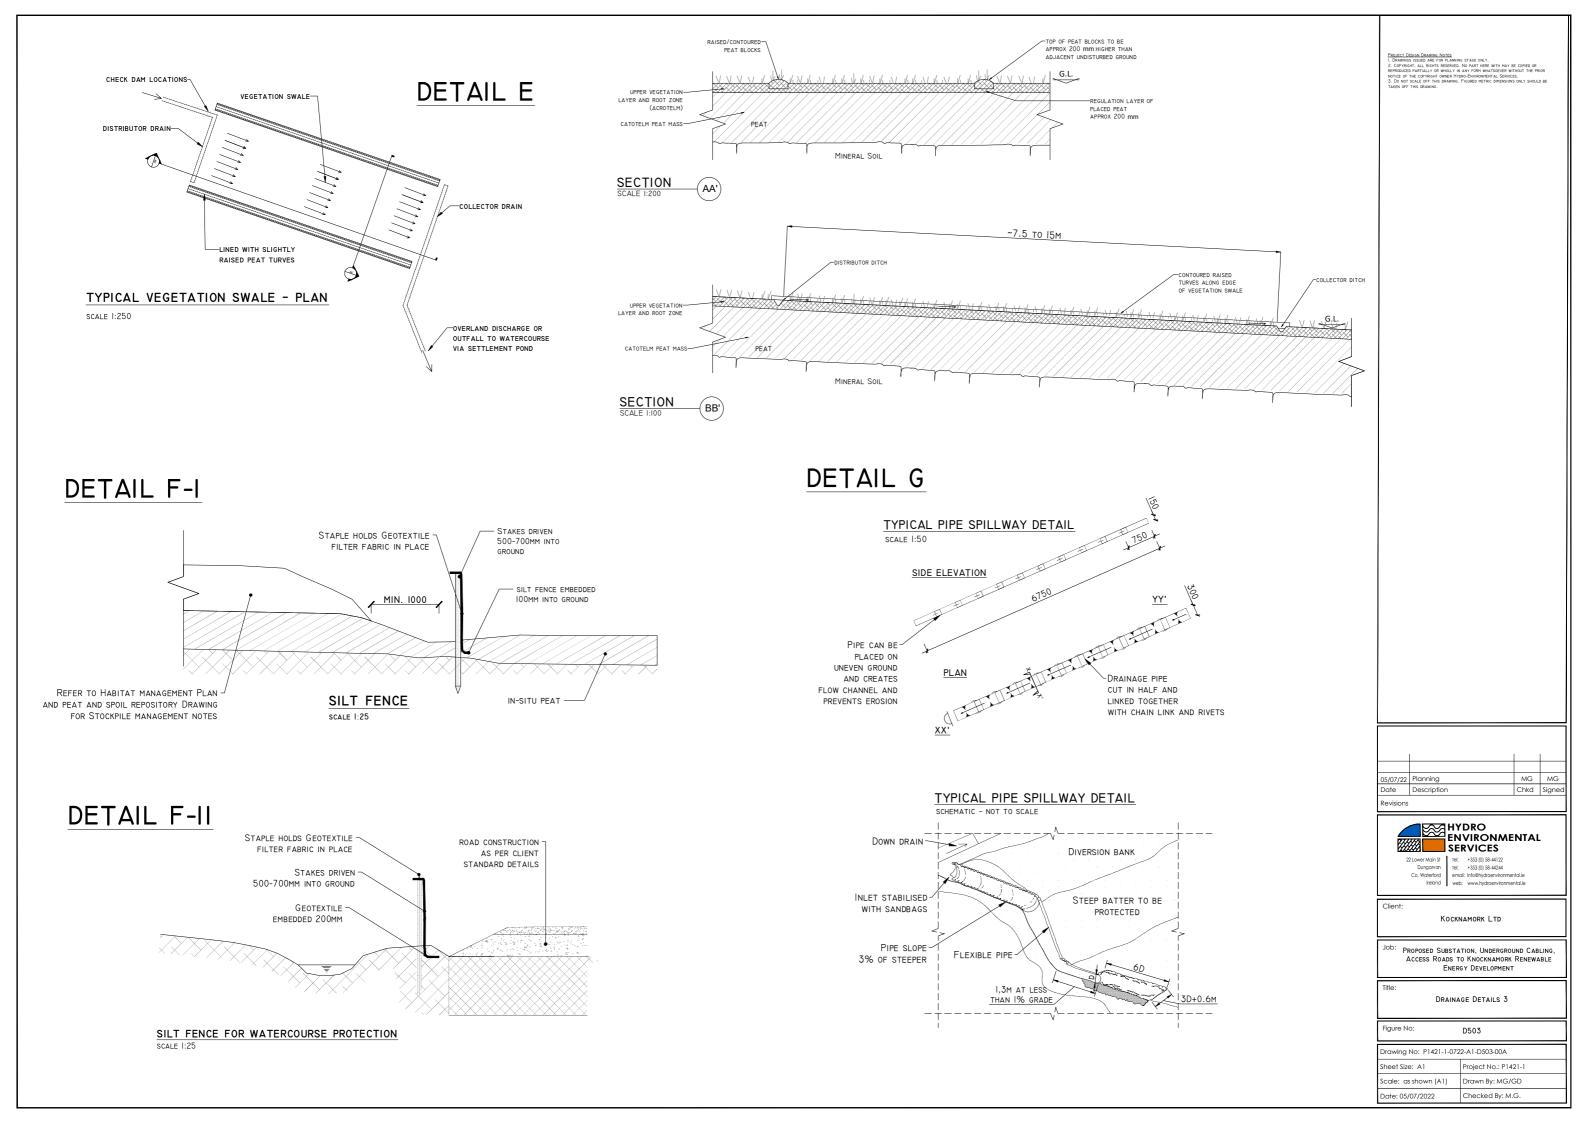



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PROJECT DESIGN DRAWING NOTES 1. DRAWINGS ISSUED ARE FOR PLANNING STAGE ONLY.

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Scale: as shown (A1) Drawn By: MG/GD

Date: 05/07/2022

Checked By: M.G.


CLEAN WATER

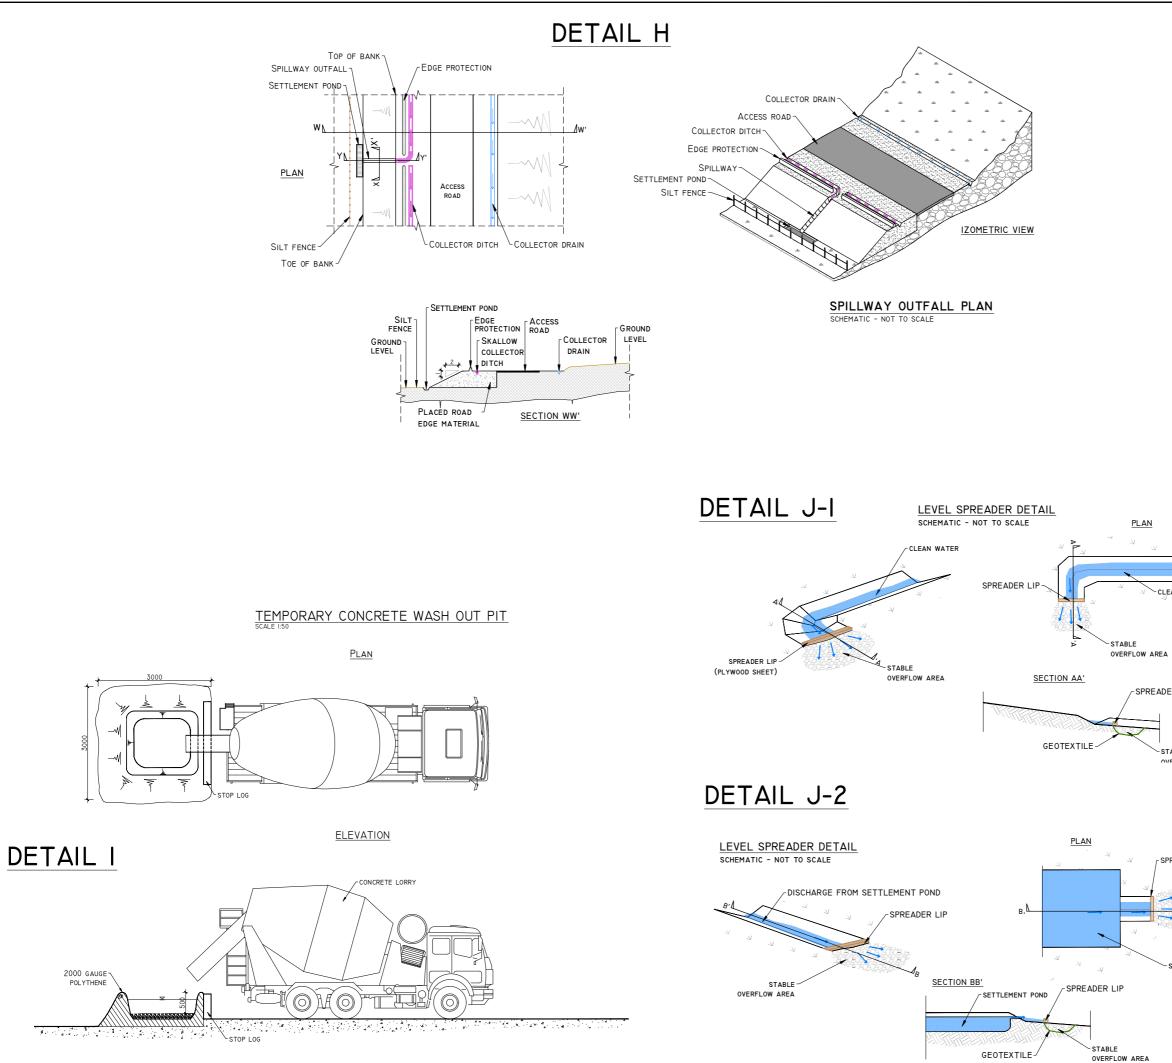SPREADER LIP

STABLE

C SPREADER LIP STABLE OVERFLOW AREA

SETTLEMENT POND

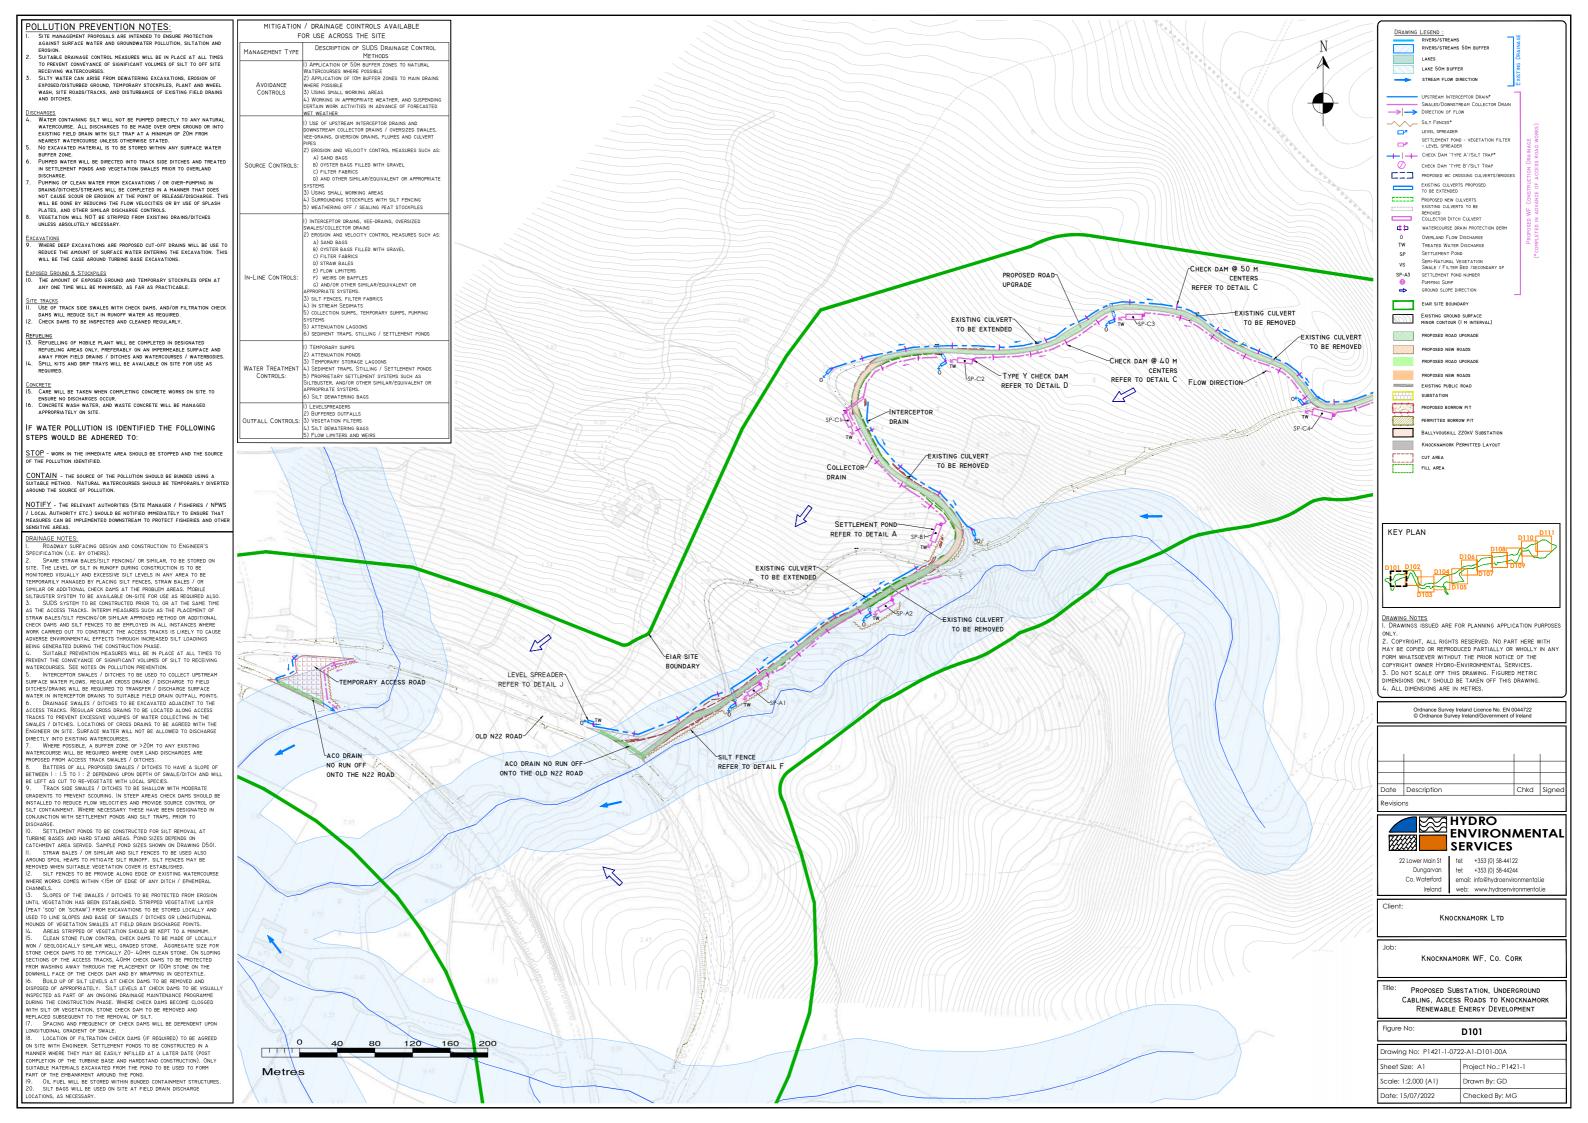

POLLUTION PREVENTION NOTES:

- AGAINST SURFACE WATER AND GROUNDWATER POLLUTION. SILTATION AND EROSION. SUITABLE DRAINAGE CONTROL MEASURES WILL BE IN PLACE AT ALL TIMES TO PREVENT CONVEYANCE OF SIGNIFICANT VOLUMES OF SILT TO OFF SITE RECEIVING WATERCOURSES. SILTY WATER CAN ARISE FROM DEWATERING EXCAVATIONS, EROSION OF EXPOSED/DISTURBED GROUND, TEMPORARY STOCKPILES, PLANT AND WHEEL WASH, SITE ROADS/TRACKS, AND DISTURBANCE OF ENSITING FIELD DRAINS
- AND DITCHES.

- CHARGES WATER CONTAINING SILT WILL NOT BE PUMPED DIRECTLY TO ANY NATURAL WATERCOURSE. ALL DISCHARGES TO BE MADE OVER OPEN GROUND OR INTO EXISTING FIELD DRAIN WITH SILT TRAP AT A MINIMUM OF 20M FROM NEAREST WATERCOURSE UNLESS OTHERWISE STATED. NO EXCAVATED MATERIAL IS TO BE STORED WITHIN ANY SURFACE WATER NEARED AND FOR STATE

- NUFFER ZONE. PUMPED WATER WILL BE DIRECTED INTO TRACK SIDE DITCHES AND TREATED NO SETLEMENT PONDS AND VECETATION SMALLS FRIOR TO VOERLAND DISCHARGE. PUMPING OF CLEAN WATER FROM EXCAVATIONS / OR OVER-PUMPING IN
- PUMPING OF CLEAN WATER FROM EXCAVATIONS / OR OVER-PUMPING IN DRAINS/OTOFENS/STREAMS WILL BE COMPLETED IN A MANNER THAT DOES NOT CAUSE SCOUR OR EROSION AT THE POINT OF RELEASE/DISCHARCE. IT WILL BE DONE BY REDUCING THE FLOW VELOCITIES OR BY USE OF SPLASH PLATES, AND OTHER SIMILAR DISCHARGE CONTROLS. VEGETATION WILL NOT BE STIMPED FROM EXISTING DRAINS/DITCHES ULLESS ABSOLUTELY NECESSARY.
- <u>(CAVATIONS</u> WHERE DEEP EXCAVATIONS ARE PROPOSED CUT-OFF DRAINS WILL BE USE TO REDUCE THE AMOUNT OF SUBFACE WATER ENTERING THE EXCAVATION. THIS WILL BE THE CASE AROUND TURBINE BASE EXCAVATIONS.

- EXPOSED GROUND & STOCKPILES 10. The amount of exposed ground and temporary stockpiles open at ANY ONE TIME WILL BE MINIMISED. AS FAR AS PRACTICABLE
- ITE TRACKS <u>L IRACKS</u> Use of track side swales with check dams, and/or filtration check dams will reduce silt in runoff water as required. Check dams to be inspected and cleaned regularly.

REFUELING 3. REFUELLING OF MOBILE PLANT WILL BE COMPLETED IN DESIGNATED

REFUELING OF HOLE LEARY THE DE CUMPERTAGE IN DESIMATES AND REFUELING AREAS ONLY, PREFERABLY ON AN IMPERMEABLE SUNFACE AND AWAY FROM FIELD DRAINS / DITCHES AND WATERCOURSES / WATERBODIES. SPILL KITS AND DRIP TRAYS WILL BE AVAILABLE ON SITE FOR USE AS REQUIRED.

<u>CONCRETE</u> 15. CARE WILL BE TAKEN WHEN COMPLETING CONCRETE WORKS ON SITE TO

ENSURE NO DISCHARGES OCCUR. CONCRETE WASH WATER, AND WASTE CONCRETE WILL BE MANAGED APPROPRIATELY ON SIT

IF WATER POLLUTION IS IDENTIFIED THE FOLLOWING STEPS WOULD BE ADHERED TO:

STOP - WORK IN THE IMMEDIATE AREA SHOULD BE STOPPED AND THE SOURCE

CONTAIN - THE SOURCE OF THE POLLUTION SHOULD BE BUNDED USING A JITABLE METHOD. NATURAL WATERCOURSES SHOULD BE TEMPORARILY DIVERTE ROUND THE SOURCE OF POLLUTION.

NOTIFY - THE RELEVANT AUTHORITIES (SITE MANAGER / FISHERIES / NPWS / Local Authority etc.) should be notified immediately to ensure that measures can be implemented downstream to protect fisheries and other sensitive areas.

- DRAINAGE NOTES: DRAINAGE NOTES: ROADWAY SUPFACING DESIGN AND CONSTRUCTION TO ENGINEER'S SPECIFICATION (I.E. BY OTHERS). 2. SFARE STRAW BALES/SILT FENCING/ OR SIMILAR. TO BE STORED ON SITE. THE LEVEL OF SILT IN RUNOFF DURING CONSTRUCTION IS TO BE MONITORED VISUALLY AND EXCESSIVE SILT LEVELS IN ANY AREA TO BE STORED WALLEOP ON UNAL AND AND CHI TEVENES STRAW BAN BE / OR D
- MONTORED VISUALLY AND EXCESSIVE SILT LEVELS IN ANY AREA TO BE TEMPORARILY MANAGED BY PLACINO SILT FENCES, STAM PLACES / OR SIMILAR OR ADDITIONAL CHECK DAMS AT THE PROBLEM AREAS. MOBILE SILTBUSTER SYSTEM TO BE AVAILABLE ON-SITE FOR USE AS REQUIRED ALSO. 3. SUDS SYSTEM TO BE CONSTRUCTED PRIOR TO, OR AT THE SAME TIME AS THE ACCESS TRACKS. INTERIM MEASURES SUCH AS THE PLACEMENT OF STRAW BALES/SILT FENCING/OR SIMILAR APPROVED METHOD OR ADDITIONAL CHECK DAMS AND SILT FENCES TO BE EMPLOYED IN ALL INSTANCES WHERE WORK CARRIED OUT TO CONSTRUCT THE ACCESS TRACKS IS LINELY TO CAUSE ADVERSE ENVIROMENTAL EFFECTS THROUGH NOREASED SILT LOADINGS BEING GENERATED DURING THE CONSTRUCTION PRASE.

SUITABLE PREVENTION MEASURES WILL BE IN PLACE AT ALL TIMES TO EVENT THE CONVEYANCE OF SIGNIFICANT VOLUMES OF SILT TO RECEIVING

PREVENT THE CONVEYANCE OF SIGNIFICANT VOLUMES OF SILT TO RECEIVING WATERCORRESS. SEE NOTES ON POLLUTION PREVENTION. 5. INTERCEPTOR SWALES / DITCHES TO BE USED TO COLLECT UPSTREAM SURFACE WATER FLOWS. REGULAR CROSS DRAINS / DISCHARGE SURFACE WATER IN INTERCEPTOR DRAINS TO SUITABLE FIELD DRAIN OUTFALL OITCHES/DRAINS WILL BE REGUIRED TO TRANSFER / DISCHARGE SURFACE WATER IN INTERCEPTOR DRAINS TO SUITABLE FIELD DRAIN OUTFALL FOR TO REGULAR CROSS DRAINS TO BE LOCATED ALONG ACCESS TRACKS. REGULAR CROSS DRAINS TO BE LOCATED ALONG ACCESS TRACKS. REGULAR CROSS DRAINS TO BE LOCATED ALONG ACCESS TRACKS TO PREVENT EXCESSIVE VOLUMES OF WATER COLLECTING IN THE SWALES / DITCHES. LOCATIONS OF CROSS DRAINS TO BE AGREED WITH THE ENGINEER ON SITE. SURFACE WATER WILL NOT BE ALLOWED TO DISCHARGE

- ENGINEER ON SITE. SUMPACE WATER WILL NOT BE ALLOWED TO DISCHAAGE DIRECTLY INTO EXISTING WATERCOURSES. 7. WHERE POSSIBLE, A BUFFER ZONE OF >20M TO ANY EXISTING WATERCOURSE WILL BE REQUIRED WHERE OVER LAND DISCHARGES ARE PROPOSED FROM ACCESS TRACK SWALES / DITCHES. 8. BATTERS OF ALL PROPOSED SWALES / DITCHES. 9. BATTERS OF ALL PROPOSED SWALES / DITCHES DITCHES. 9. BATTERS OF ALL PROPOSED SWALES / DITCHES DITCHES. 9. BATTERS OF ALL PROPOSED SWALES / DITCHES DIT

BE LEFT AS CUT TO HE-VEGETATE WITH LOCAL SPECIES. 9. TRACK SIDE SWALES / DICHES TO BE SHALLOW WITH MODERATE GRADIENTS TO PREVENT SCOURING. IN STEEP AREAS CHECK DAMS SHOULD BE INSTALLED TO REDUCE FLOW VELOCITIES AND PROVIDE SOURCE CONTROL OF SLIT CONTINNENT. WHERE NECESSARY THESE HAVE BEEN DESIGNATED IN CONJUNCTION WITH SETTLEMENT PONDS AND SILT TRAPS, PRIOR TO DOCUMENT

CONJUNCTION WITH SETILEMENT PONDS AND SILT THATS, PHOR TO DISCHARGE. 10. SETTLEMENT PONDS TO BE CONSTRUCTED FOR SILT REMOVALAT TURBINE BASES AND HARD STAND AREAS. POND SIZES DEPENDS ON CATCHMENT AREA SERVED. SAMPLE POND SIZES SHOWN ON DRAWING DÖDI. 11. STRAW BALES / OR SIMILAR AND SILT FENCES TO BE USED ALSO AROUND SPOL HEAPS TO MITIGATE SILT RUNGF. SILT FENCES MAY BE

AROUND SPOL HEAFS TO MITIGATE SLET RUNUFF. SLET FENCES MAY BE REMOVED WHEN SUITABLE VEGETATION COVER IS ESTABLISHED. 2. SILT FENCES TO BE PROVIDE ALONG EDGE OF EXISTING WATERCOURSE WHERE WORKS COMES WITHIN <15M OF EDGE OF ANY DITCH / EPHEMERAL


MERE WORKS CORES WITHIN YOU OF EDGE OF ANY DITCH / EPREMAL CHANNELS. 13. SLOPES OF THE SWALES / DITCHES TO BE PROTECTED FROM EROSION UNTIL VECTATION HAS BEEN ESTABLISHED. STRIPPEO VEGETATIVE LAYER (PEAT 'SOD' OR 'SCRAW') FROM EXCAVATIONS TO BE STORED LOCALLY AND USED TO LINE SLOPES AND BASE OF SWALES' DITCHES OR LONGTUDINAL MOUNDS OF VEGETATION SWALES AT FIELD DRAIN DISCHARGE POINTS. 14. APRAS STRIPPED OF VEGETATION SHOULD BE KEPT TO A MINIMUM. 15. CLEAN STORE FLOW CONTROL CHECK DAMS TO BE MADE OF LOCALLY


I5. CLEAN STONE FLOW CONTROL CHECK DAMS TO BE MADE OF LOCALLY WOM / GEOLOGICALLY SINULAR WELL GRADED STONE. AGGREGATE SIZE FOR STONE CHECK DAMS TO BE TYPICALLY 20- 40MM CLEAN STONE. ON SLOPING SECTIONS OF THE ACCESS TRACKS, 40MM CHECK DAMS TO BE PROTECTED FROM WASHING MAWY THROUGH THE PLACEMENT OF IODN STONE ON THE DOWNHILL FACE OF THE CHECK DAM AND BY WRAPPING IN GEOTEXTILE. 16. BUILD UP SILT LEVELS AT CHECK DAMS TO BE REMOVED AND DISPOSED OF APPROPRIATELY. SILT LEVELS AT CHECK DAMS TO BE REMOKED AND DISPOSED OF APPROPRIATELY. SILT LEVELS AT CHECK DAMS TO BE REMOKED AND DISPOSED OF APPROPRIATELY. SILT LEVELS AT CHECK DAMS TO BE REMOKED DURING THE CONSTRUCTION PHASE. WHERE CHECK DAMS BECOME LOGGED ITH SILT OR VEGETATION, STONE CHECK DAM TO BE REMOVED AND REPLACED SUBSEQUENT TO THE REM VAL OF SILT.

SPACING AND FREQUENCY OF CHECK DAMS WILL BE DEPENDENT UPON NGITUDINAL GRADIENT OF SWALE. . LOCATION OF FILTRATION CHECK DAMS (IF REQUIRED) TO BE AGREED

N SITE WITH ENGINEER. SETTLEMENT PONDS TO BE CONSTRUCTED IN A ANNER WHERE THEY MAY BE EASILY INFILLED AT A LATER DATE (POST OMPLETION OF THE TURBINE BASE AND HARDSTAND CONSTRUCTION). ONLY UITABLE MATERIALS EXCAVATED FROM THE POND TO BE USED TO FORM

PART OF THE EMBANKMENT AROUND THE POND. 9. OIL FUEL WILL BE STORED WITHIN BUNDED CONTAINMENT STRUCTURES. 20. SILT BAGS WILL BE USED ON SITE AT FIELD DRAIN DISCHARGE LOCATIONS, AS NECESSARY.

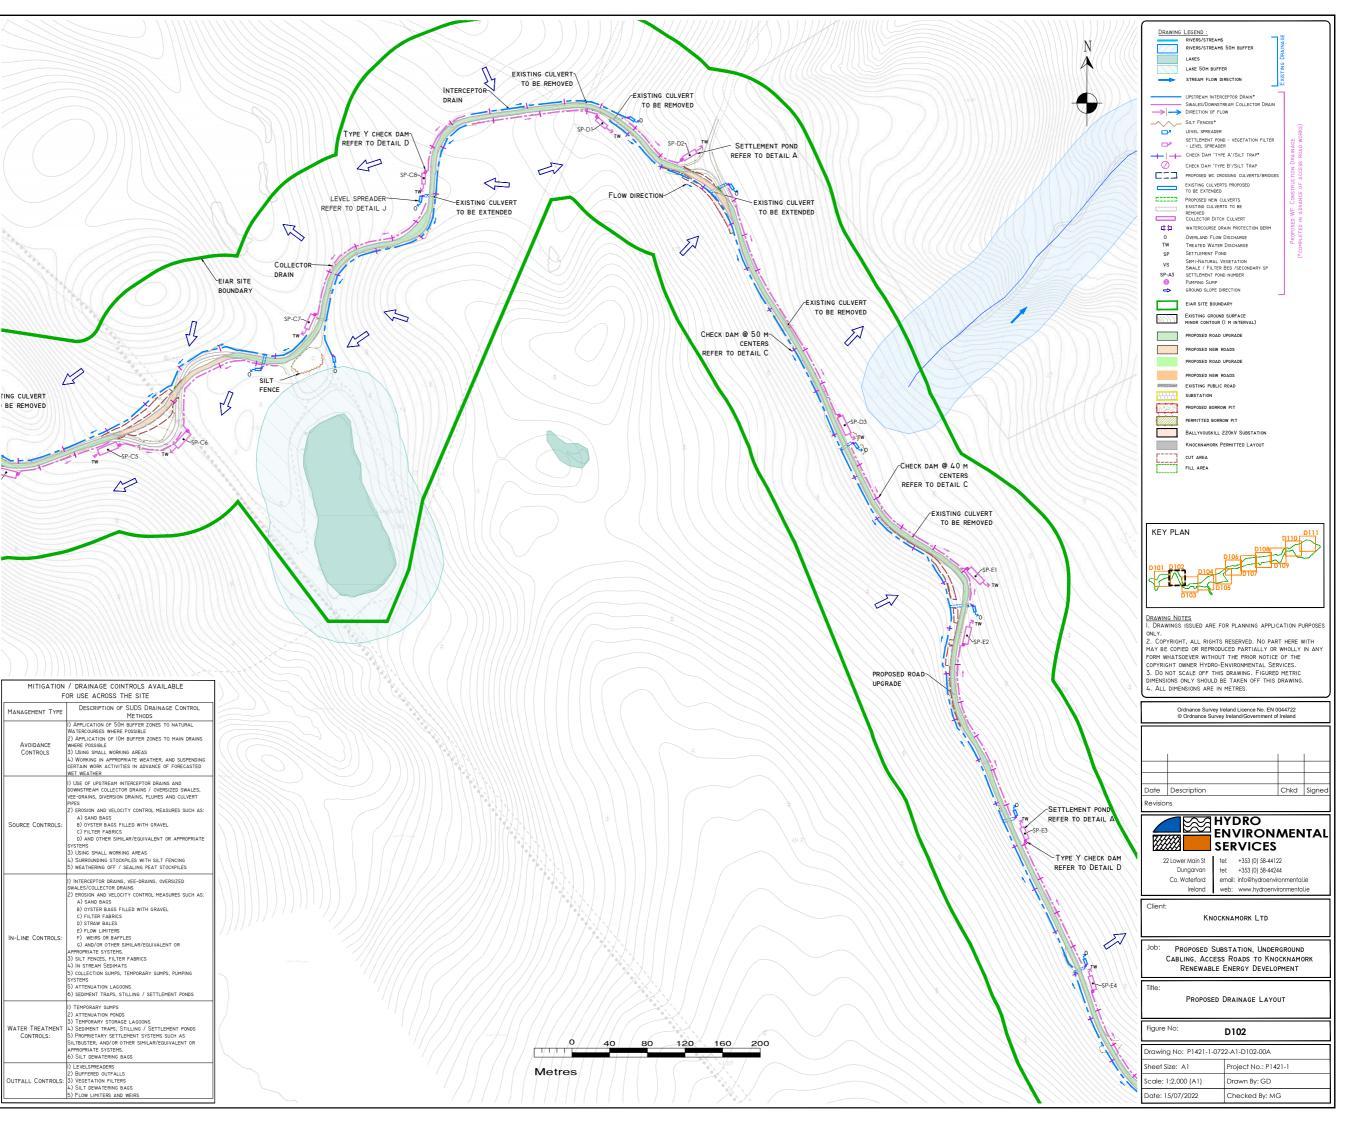

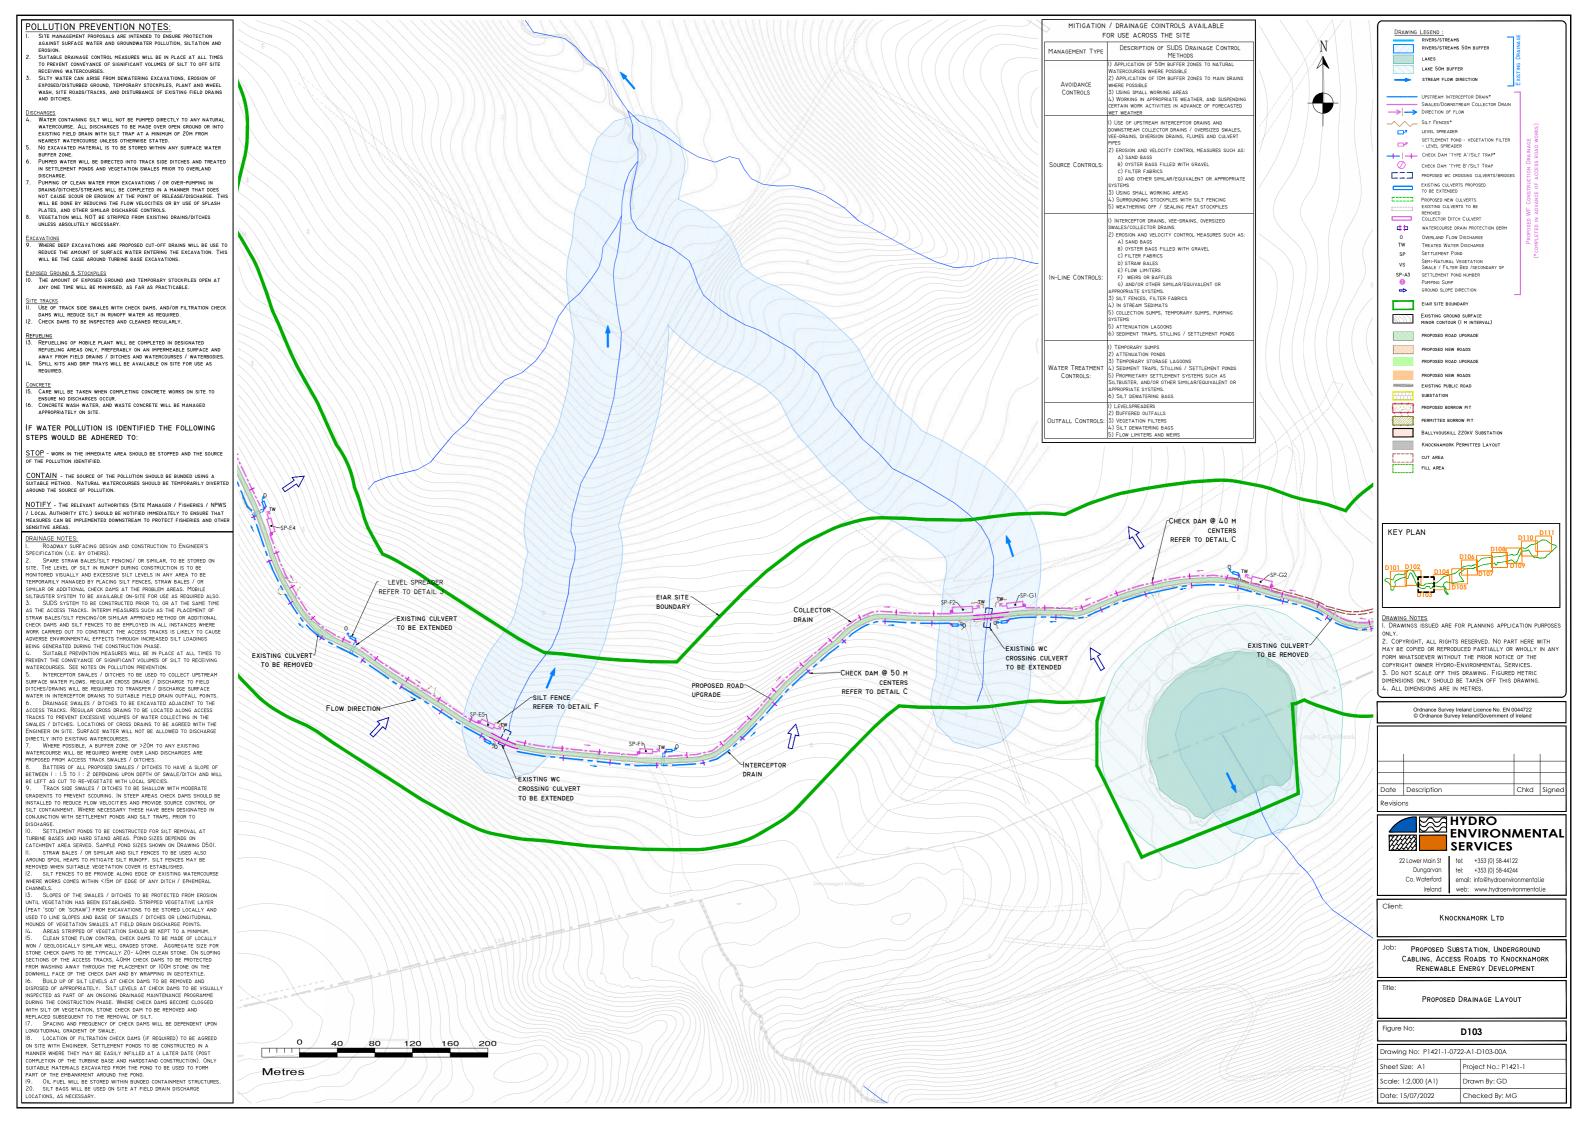

POLLUTION PREVENTION NOTES:

- JRE PROTECTION AGAINST SURFACE WATER AND GROUNDWATER POLLUTION. SILTATION AND
- EROSION. SUITABLE DRAINAGE CONTROL MEASURES WILL BE IN PLACE AT ALL TIMES TO PREVENT CONVEYANCE OF SIGNIFICANT VOLUMES OF SILT TO OFF SITE RECEIVING WATERCOURSES. SILTY WATER CAN ARISE FROM DEWATERING EXCAVATIONS, EROSION OF EXPOSED/DISTURBED GROUND, TEMPORARY STOCKPLES, PLANT AND WHEEL WASH, SITE ROADS/TRACKS, AND DISTURBANCE OF EXISTING FIELD DRAINS AND DITCHES.

- DISCHARGES . WATER CONTAINING SILT WILL NOT BE PUMPED DIRECTLY TO ANY NATURAL WATERCORDES. ALL DISCHARGES TO BE MADE OVER OPEN GROUND OR INTO EXISTING FIELD DRAIN WITH SILT TRAP AT A MINIMUM OF 20M FROM NEAREST WATERCOURSE UNLESS OTHERWISE STATED. 5. NO EXCAVATED MATERIAL IS TO BE STORED WITHIN ANY SURFACE WATER

- NO EXCAVATED MATERIAL IS TO BE STORED WITHIN ANY SURFACE WATER PUMPED WATER WILL BE DIRECTED INTO TRACK SIDE DITCHES AND TREATED IN SETTLEHENT FONDS AND VEGETATION SWALES PRIOR TO OVERLAND DISCHARGE. PUMPING OF CLEAN WATER FROM EXCAVATIONS / OR OVER-PUMPING IN DRAINS/DITCHES/STREAMS WILL BE COMPLETED IN A MANNER THAT DOES PUMPING OF CLEAN WATER FROM EXCAVATIONS / OR OVER-PUMPING IN DRAINS/TOITEAS/STREAMS WILL BE COMPLETED IN A MANNER THAT DOES NOT CAUSE SCOUR OR EROSION AT THE POINT OF RELEASE/DISCHARGE. THIS WILL BE DONE BY REDUICING THE FLOW VELOCITES OR BY USE OF SPLASH PLATES, AND OTHER SIMILAR DISCHARGE CONTROLS. VEGETATION WILL NOT BE STRIPPED FROM EXISTING DRAINS/DITCHES UNLESS ABSOLUTELY NECESSARY.

EXCAVATIONS 9. Where deep excavations are proposed cut-off drains will be use to reduce the amount of surface water entering the excavation. This will be the case around turbine base excavations.

- EXPOSED GROUND & STOCKPILES 10. THE AMOUNT OF EXPOSED GROUND AND TEMPORARY STOCKPILES OPEN AT ANY ONE TIME WILL BE MINIMISED, AS FAR AS PRACTICABLE.
- <u>SITE TRACKS</u> 11. Use of track side swales with check dams, and/or filtration check dams will reduce silt in runoff water as required. 12. Check dams to be inspected and cleaned regularly.

<u>Refueling</u> 13. Refuelling of mobile plant will be completed in designated

REFUELING OF HOLE LEARY THE DE CUMPERTAGE IN DESIMATE AND REFUELING AREAS ONLY, PREFERABLY ON AN IMPERMEABLE SUNFACE AND AWAY FROM FIELD DRAINS / DITCHES AND WATERCOURSES / WATERBODIES. SPILL KITS AND DRIP TRAYS WILL BE AVAILABLE ON SITE FOR USE AS REQUIRED.

 $\frac{\text{Concrete}}{\text{I5. Care will be taken when completing concrete works on site to}}$ ENSURE NO DISCHARGES OCCUR. CONCRETE WASH WATER, AND WASTE CONCRETE WILL BE MANAGED

IF WATER POLLUTION IS IDENTIFIED THE FOLLOWING STEPS WOULD BE ADHERED TO:

STOP - WORK IN THE IMMEDIATE AREA SHOULD BE STOPPED AND THE SOURCE

<u>CONTAIN</u> - THE SOURCE OF THE POLLUTION SHOULD BE BUNDED USING A SUITABLE METHOD. NATURAL WATERCOURSES SHOULD BE TEMPORARILY DIVERT AROUND THE SOURCE OF POLLUTION.

NOTIFY - THE RELEVANT AUTHORITIES (SITE MANAGER / FISHERIES / NPWS / Local Authority etc.) should be notified immediately to ensure that measures can be implemented downstream to protect fisheries and other sensitive areas.

SENSITIVE AREAS. DRAINAGE NOTES: I. ROGOWAY SUFFACING DESIGN AND CONSTRUCTION TO ENGINEER'S SPECIFICATION (I.E. BY OTHERS). 2. SPARE STAW BALES/SILT FENCING/ OR SIMILAR, TO BE STORED ON SITE. THE LEVEL OF SILT IN RINDFF DURING CONSTRUCTION IS TO BE MONITORED VISUALLY AND EXCESSIVE SILT LEVELS IN ANY AREA TO BE TEMPORARILY MANAGED BY PLACING SILT FENCES, STRAW BALES / OR SIMILAR OR ADDITIONAL CHECK DAMS AT THE FROBLEM AREAS. MOBILE SILTBUSTER SYSTEM TO BE AVAILABLE ON-SITE FOR USE AS REQUIRED ALSO. 3. SUDS SYSTEM TO BE CONSTRUCTED FRIGT TO, BA T THE SAME THE SAT THE ACCESS TRACKS. INTERIM MEASURES SULCH AS THE FLACEMENT OF STRAW BALES/SILT FENCING/OR SIMILAR APPROVED METHOD OR ADDITIONAL CHECK DAMS AND SILT FENCES TO BE EMPLOYED IN ALL INSTRUCES WHERE WORK CARRIED OUT TO CONSTRUCT THE ACCESS TRACKS IS LIKELY TO CAUSE ADVERSE EVINORMENTAL EFFECTS THROUGH INCERASED SILT LADINGS BEING GENERATED DURING THE CONSTRUCTION FLASE. 4. SUITALE PREVENTION THE ASSURES SULCE IN PLACES AT ALL TIMES TO PREVENT THE CONFERENCE ON DURING THE CONSTRUCTION FLASE.

4. SUITABLE PREVENTION MEASURES WILL BE IN PLACE AT ALL TIMES TO PREVENT THE CONVEYANCE OF SIGNIFICANT VOLMES OF SUIT TO RECEIVING WATERCOURSES. SEE NOTES ON POLLITION PREVENTION. 5. INTERCEPTOR SWALES / DITCHES TO BE USED TO COLLECT UPSTREAM SUFACE WATER FLOWS. REGULAR CROSS DRAINS / DISCMARGE TO FIELD DITCHES/DRAINS WILL BE REQUIRED TO TRANSFER / DISCMARGE TO FIELD DITCHES/DRAINS WILL BE REQUIRED TO TRANSFER / DISCMARGE TO FIELD ANTER IN INTERCEPTOR DRAINS TO SUITABLE FIELD DRAIN OUTFALL POINTS. 6. DRAINAGE SWALES / DITCHES TO BE ENCAVATED ADJACENT TO THE ACCESS TRACKS. REGULAR CROSS DRAINS TO BE LOCATED ALDICANE ACCESS TRACKS TO PREVENT EXCESSIVE VOLUMES OF WATER COLLECTING IN THE SWALES / DITCHES. LOCATIONS OF CROSS DRAINS TO BE ADDREED WITH THE ENGINEER ON SITE. SUIFACE WATER WILL NOT BE ALLOWED TO DISCHARGE DIRECTLY INFO EXISTING WATERCOURSES.

ENGINEER ON SITE. SUMFACE WATER WILL NOT BE ALLOWED TO DISCHARGE DIRECTLY INTO EXISTING WATERCOURSES. 7. WHERE POSSIBLE, A BUFFER ZONE OF >20M TO ANY EXISTING WATERCOURSES WILL BE REQUIRED WHERE OVER LAND DISCHARGES ARE PROPOSED FROM ACCESS TRACK SWALES / DITCHES. 8. BATTERS OF ALL REPORTSOE SWALES / DITCHES. 8. BATTERS OF ALL REPORTSOE SWALES / DITCHES TO HAVE A SLOPE OF BETWEEN I :1.5 TO I : 2 DEPENDING UPON DEPTH OF SWALE/DITCH AND WILL BE LEFT AS CUT TO RE-VEGETARE WITH LOCAL SPECIES. 9. TRACK SIDE SWALES / DITCHES TO BE SHALLOW WITH MODERATE EXPONENTS TO BEEVENT CONVEND. IN STEED REAR CHECK DOWN SUND IN SEC

7. TRACK SUG STALLES / UTCHES TO BE STALLUW WITH PODERATE GRADENTS TO PREVENT SCOURSE. IN STEEP AREAS CHECK DARKS SHOULD BE INSTALLED TO REDUCE FLOW VELOCITIES AND PROVIDE SOURCE CONTROL OF SLIT CONTAINMENT. WHERE NECESSARY THESE HAVE BEEN DESIGNATED IN CONJUNCTION WITH SETTLEMENT PONDS AND SILT TRAFS, PRIOR TO

LUNDART IN THIS & THENKING SHE CONSTRUCTED FOR SILT REMOVAL AT USCHARGE. 10. SETTLEHENT PONDS TO BE CONSTRUCTED FOR SILT REMOVAL AT TURBINE BASES AND HARD STAND AREAS. POND SIZES DEPENDS ON CATCHMENT AREA SERVED. SAMPLE POND SIZES SHOWN ON DRAWING DSOIL 11. STRAW BALES / OR SIMULAR AND SILT FENCES TO BE USED ALSO AROUND SPOIL HEARS TO MITIGATE SILT RUNDEF. SILT FENCES MAY BE STRAW STRAW STRAW STRAW STRAW STRAW STRAW STRAW AND SPOIL HEARS TO MITIGATE SILT RUNDEF. SILT FENCES MAY BE STRAW S


AROUND SFUL HEAFS ID MINIGATE SLET RUNOFF. SLET FENCES MAY BE REMOVED WHEN SUITABLE VEGETATION COVER IS ESTABLISHED. 12. SLET FENCES TO BE PROVIDE ALONG EDGE OF EXISTING WATERCOURSE WHERE WORKS COMES WITHIN <15M OF EDGE OF ANY DITCH / EPHEMERAL

Where WORKS COMES WITHIN YOU OF DOE OF ANT DITCH PERFEREN-ICANNELS. 13. SLOPES OF THE SWALES / DITCHES TO BE PROTECTED FROM REGOSION UNIT. VEGETATION HAS BEEN ESTABLISHED. STRIPPED VEGETATIVE LAYER (FEAT '50D' OR 'SCRAW') FROM EXCAVATIONS TO BE STORED LOCALLY AND USED TO LINE SLOPES AND BASE OF SWALES / DITCHES OR LOWISTIONNAL MOUNDS OF VEGETATION SWALES AT FIELD DRAIN DISCHARGE POINTS. 14. AREAS STIPPED OF VEGETATION SHOLD BE KEPT TO A MINIMUM. 15. CLEAN STOWE FLOW CONTROL CHECK DAMS TO BE MADE OF LOCALLY


15. CLEAN STONE FLOW CONTROL CHECK DAMS TO BE MADE OF LOCALLY WOW / GEOLOGICALLY SINULAR WELL GRADED STONE. AGGREGATE SIZE FOR STONE CHECK DAMS TO BE TYPICALLY 20- 40MM CLEAN STONE. ON SLOPING SECTIONS OF THE ACCESS TRACKS, 40MM CHECK DAMS TO BE PROTECTED FROM WASHING AWAY THROUGH THE PLACEMENT OF 100M STONE ON THE DOWNILL FACE OF THE CHECK DAM AND BY WRAPPING IN GEOTEXTILE. 16. BUILD UP SILT LEVELS AT CHECK DAMS TO BE REWORDED AND DISPOSED OF APPROPRIATELY. SILT LEVELS AT CHECK DAMS TO BE REWORDED AND DISPOSED OF APPROPRIATELY. SILT LEVELS AT CHECK DAMS TO BE REWORDED DURING THE CONSTRUCTION PHASE. WHERE CHECK DAMS BECOME CLOGGED WITH SILT OR VEGETATION, STONE CHECK DAM TO BE REMOVED AND REPLACED SUBSEQUENT TO THE REMOVAL OF SILT.

SPACING AND FREQUENCY OF CHECK DAMS WILL BE DEPENDENT UPON


.ONGITUDINAL GRADIENT OF SWALE. 8. LOCATION OF FILTRATION CHECK DAMS (IF REQUIRED) TO BE AGREED ON SITE WITH ENGINEER. SETTLEMENT PONDS TO BE CONSTRUCTED IN A MANNER WHERE THEY MAY BE EASILY INFILLED AT A LATER DATE (POST MANNEN WHERE IHEY MAY BE EASILY INFILLED AT A LATER DATE (1905) COMPLETION OF THE TURBINE BEAS AND HARDSTADE CONSTRUCTION. ONLY SUITABLE MATERIALS EXCAVATED FROM THE FOND TO BE USED TO FORM PART OF THE MEMANIKENT AROUND THE FOND. 19. OIL FUEL WILL BE STORED WITHIN BUNDED CONTAINMENT STRUCTURES 20. SILT BAGS WILL BE USED ON SITE AT FIELD DRAIN DISCHARGE LOCATIONS, AS VECESSARY.

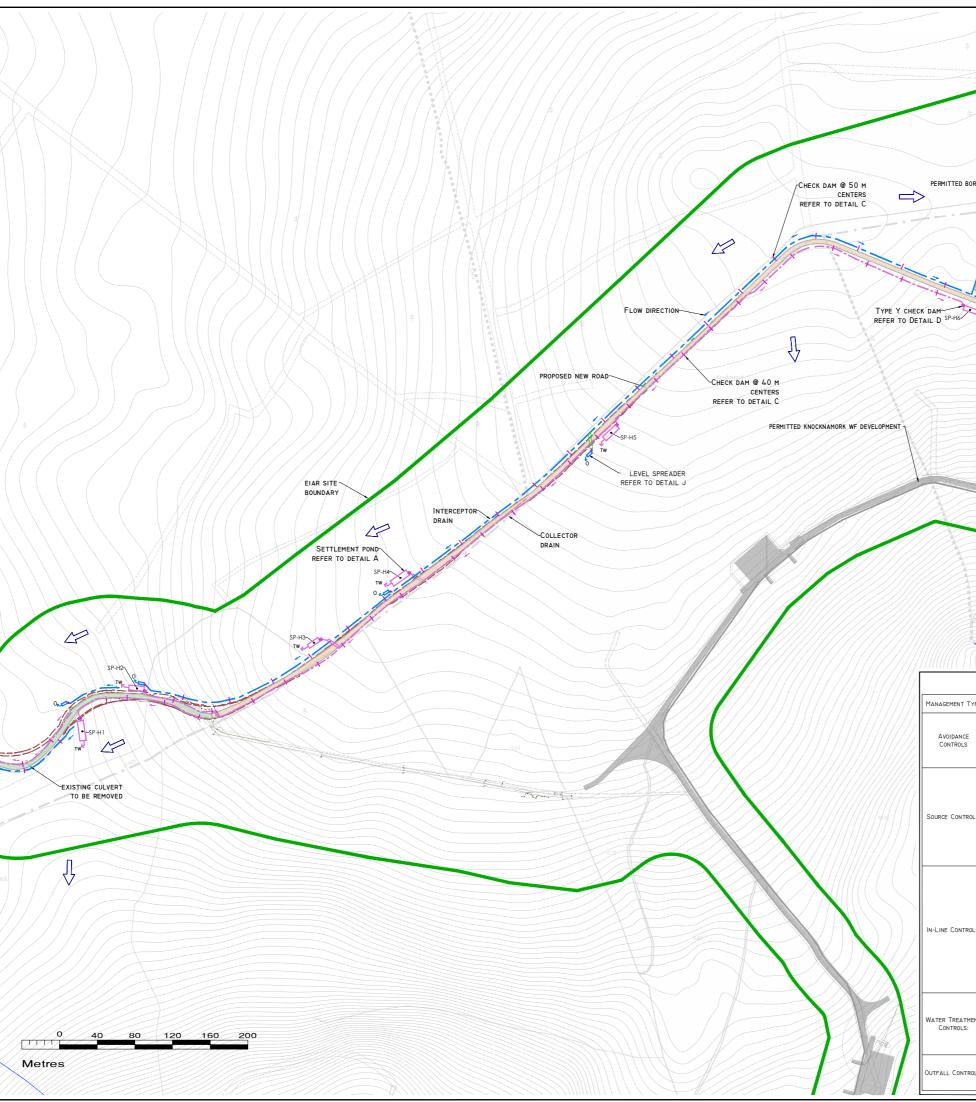

	N *	DRAWING LEGEND : RIVERS/STREAMS RIVERS/STREAMS SOM BUFFER LAKES LAKE SOM BUFFER LAKE SOM BUFFER STREAM FLOW DIRECTION UPSTREAM INTERCEPTOR DRAIN*
*		SWALES/DOWNSTREAM COLLECTOR DRAN DIRECTION OF FLOW LEVEL SPREADER STLEMENT ROD - VEGETATION FILTER - LEVEL SPREADER CHECK DAM 'TYPE B'/SILT TRAP CHECK DAM 'TYPE B'/SILT TRAP
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	OR USE ACROSS THE SITE	DRAWING NOTES 1. DRAWINGS ISSUED ARE FOR PLANNING APPLICATION PURPOSES ONLY. 2. COPYRIGHT, ALL RIGHTS RESERVED. NO PART HERE WITH MAY BE COPIED OR REPRODUCED PARTIALLY OR WHOLLY IN ANY FORW WHATSOEVER WITHOUT THE FOR NOTICE OF THE COPYRIGHT OWNER HYDRO-ENVIRONMENTAL SERVICES. 3. DO NOT SCALE OFF THIS DRAWING. FIGURED METRIC DIMENSIONS ONLY SHOULD BE TAKEN OFF THIS DRAWING. 4. ALL DIMENSIONS ARE IN METRES.
MENT TYPE	DESCRIPTION OF SUDS DRAINAGE CONTROL	Ordnance Survey Ireland Licence No. EN 0044722
DANCE TROLS) METHODS 10 APPLICATION OF 50M BUFFER ZONES TO NATURAL WATERCOURSES WHERE POSSIBLE 2) APPLICATION OF 10M BUFFER ZONES TO MAIN DRAINS WHERE POSSIBLE 3) USING SMALL WORKING AREAS 4) WORKING N APPORPIRATE WEATHER, AND SUSPENDING CERTIAN WORK ACTIVITIES IN ADVANCE OF FORECASTED WET WEATHER	© Ordnance Survey Ireland/Government of Ireland
Controls:	I) USE OF UPSTREAM INTERCEPTOR DRAINS AND DOWNSTREAM COLLECTOR DRAINS / VVERISZED SWALES, VVEFCRAINS, DVERGIND RAINS, FLUMES AND CULVERT PIPES 2) ENGION AND VELOCITY CONTROL MEASURES SUCH AS: A) SAND BAGS B) OYSTER BAGS FILLED WITH GRAVEL C) FILTER FABRICS D) AND OTHER SIMILAP/COUVALENT OR APPROPRIATE SYSTEMS 3) USING SHALL WORKING AREAS 4) SURGNUNDING STOCKPLES WITH SILT FENCING 5) WEATHERING OF / SALLING PEAT STOCKPLES	Date Description Chkd Signed Revisions HYDRO EN VIRONMENTAL SERVICES 22 Lower Main St tet: +353 (0) 58-44122 22 Lower Main St tet: +353 (0) 59-44122
Controls:	OF INCENTIONING OF IF SECURITIES (INTERCEPTOR DRAINS, VEE-DRAINS, OVERSIZED SWALES/COLLECTOR DRAINS 2) ENGISION AND VELOCITY CONTROL MEASURES SUCH AS: A) SAND BAGS B) OYSTER BAGS FILLED WITH GRAVEL C) FLITER FARMICS D) STRAW BALES FLOW WINTERS F) WEIRS OR BAFFLES () AND/OR OTHER SIMILAR/EQUIVALENT OR APROPRIATE SYSTEMS. S) SLITERNES, FLITER FABRICS 4) IN STREAM SEDIMATS S) COLLECTION SUMPS, TEMPORARY SUMPS, PUMPING SYSTEMS	Dungarvan Co. Waterford Ireland Co. Waterford Ireland Client: KNOCKNAMORK LTD Job: PROPOSED SUBSTATION, UNDERGROUND CABLING, ACCESS ROADS TO KNOCKNAMORK RENEWABLE ENERGY DEVELOPMENT
REATMENT TROLS:	5) A TERNATION LAGOONS 6) SEDIMENT TRAPS, STILLING / SETTLEMENT PONDS 2) ATTENDATION POINDS 2) ATTENDATION POINDS 2) ATTENDATION POINDS 3) TERMORARY STORAGE LAGOONS 6) PROFILETARY SETLEMENT SYSTEMS SUCH AS 5) PROFILETARY SETLEMENT SYSTEMS SUCH AS 5) TRUETTRAPS, STILLING / SETLEMENT ON APPROFILETARY SETLEMENT SHILLAP/EDUIVALENT OR APPROFILETARY SETLEMENT SHILLAP/EDUIVALENT OR APPROFILETARY SETLEMENT SAID	Title: PROPOSED DRAINAGE LAYOUT Figure No: D104 Drawing No: P1421-1-0722-A1-D104-00A
CONTROLS:) Levelspreaders 2) Buffred Outfalls 3) Vegetation filters 4) Silt dewatering bags 5) Flow limiters and weirs	Sheet Size: A1 Project No.: P1421-1 Scale: 1:2,000 (A1) Drawn By: GD Date: 15/07/2022 Checked By: MG

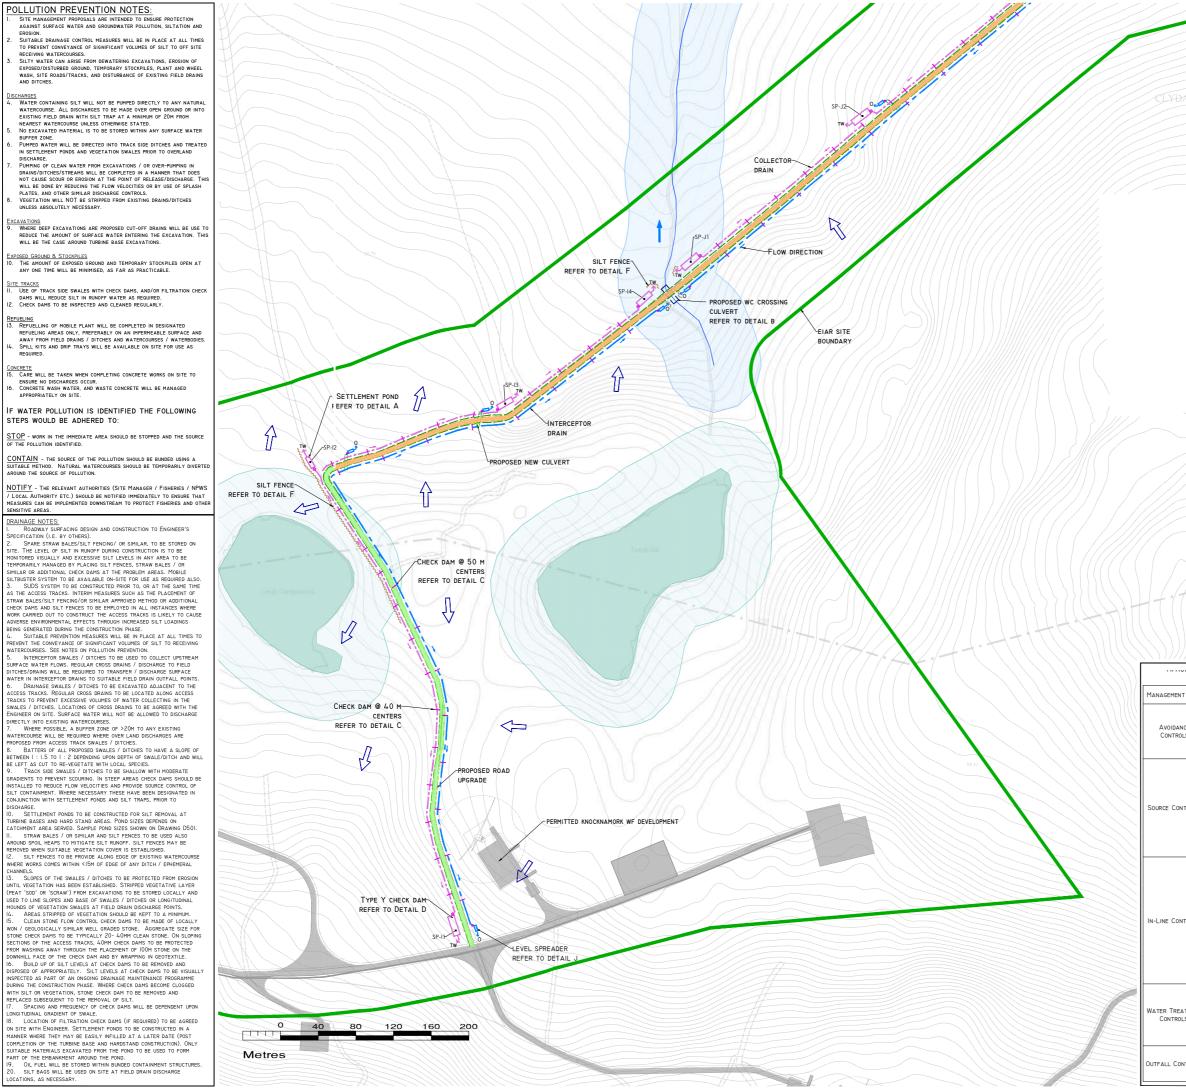

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(DAGH	ROE		DIRECTION OF	ISTREAM COLLECTOR DRAIN FLOW		
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MENT TYPE	DESCRIPTION OF SUDS DRAINAGE CONTROL			/ Ireland Licence No. EN		
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DANCE	2) APPLICATION OF IOM BUFFER ZONES TO MAIN DRAINS WHERE POSSIBLE					
TROLS	 USING SMALL WORKING AREAS WORKING IN APPROPRIATE WEATHER, AND SUSPENDING CERTAIN WORK ACTIVITIES IN ADVANCE OF FORECASTED 				-	
	WET WEATHER I) USE OF UPSTREAM INTERCEPTOR DRAINS AND					
	DOWNSTREAM COLLECTOR DRAINS / OVERSIZED SWALES, VEE-DRAINS, DIVERSION DRAINS, FLUMES AND CULVERT PIPES	Date Des Revisions	scription		Chkd	Signed
C	2) EROSION AND VELOCITY CONTROL MEASURES SUCH AS: A) SAND BAGS			HYDRO		=
CONTROLS:	 B) OYSTER BAGS FILLED WITH GRAVEL C) FILTER FABRICS D) AND OTHER SIMILAR/EQUIVALENT OR APPROPRIATE 			ENVIRON	MEN	ITAL
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	4) SURROUNDING STOCKPILES WITH SILT FENCING 5) WEATHERING OFF / SEALING PEAT STOCKPILES	D	er Main St Dungarvan	tel: +353 (0) 58-441 tel: +353 (0) 58-442	44	
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	 2) EROSION AND VELOCITY CONTROL MEASURES SUCH AS: A) SAND BAGS B) OYSTER BAGS FILLED WITH GRAVEL 	Client:				=
	C) FILTER FABRICS D) STRAW BALES E) FLOW LIMITERS		KNO	CKNAMORK LTD		
CONTROLS:	 F) WEIRS OR BAFFLES G) AND/OR OTHER SIMILAR/EQUIVALENT OR 	Job: Pr				
	APPROPRIATE SYSTEMS. 3) SILT FENCES, FILTER FABRICS 4) IN STREAM SEDIMATS	Саві	ling, Acce	UBSTATION, UNDER	оскламо	
	 COLLECTION SUMPS, TEMPORARY SUMPS, PUMPING SYSTEMS 		KENEWABL	E ENERGY DEVELO	PMENT	
	5) ATTENUATION LAGOONS 6) SEDIMENT TRAPS, STILLING / SETTLEMENT PONDS	Title:	PROPOSE	DRAINAGE LAYO	UT	
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REATMENT	 TEMPORARY STORAGE LAGOONS SEDIMENT TRAPS, STILLING / SETTLEMENT PONDS PROPRIETARY SETTLEMENT SYSTEMS SUCH AS 	Figure No:		D105		
	SILTBUSTER, AND/OR OTHER SIMILAR/EQUIVALENT OR APPROPRIATE SYSTEMS.	Drawing No	p: P1421-1-0	722-A1-D105-00A		=
	6) SILT DEWATERING BAGS 1) LEVELSPREADERS 2) RUFFERED OUTFALLS	Sheet Size:		Project No.: P14	21-1	
CONTROLS:	2) BUFFERED OUTFALLS 3) VEGETATION FILTERS 4) SILT DEWATERING BAGS	Scale: 1:2,0	00 (A1)	Drawn By: GD		
	5) FLOW LIMITERS AND WEIRS	Date: 15/07	/2022	Checked By: M	G	

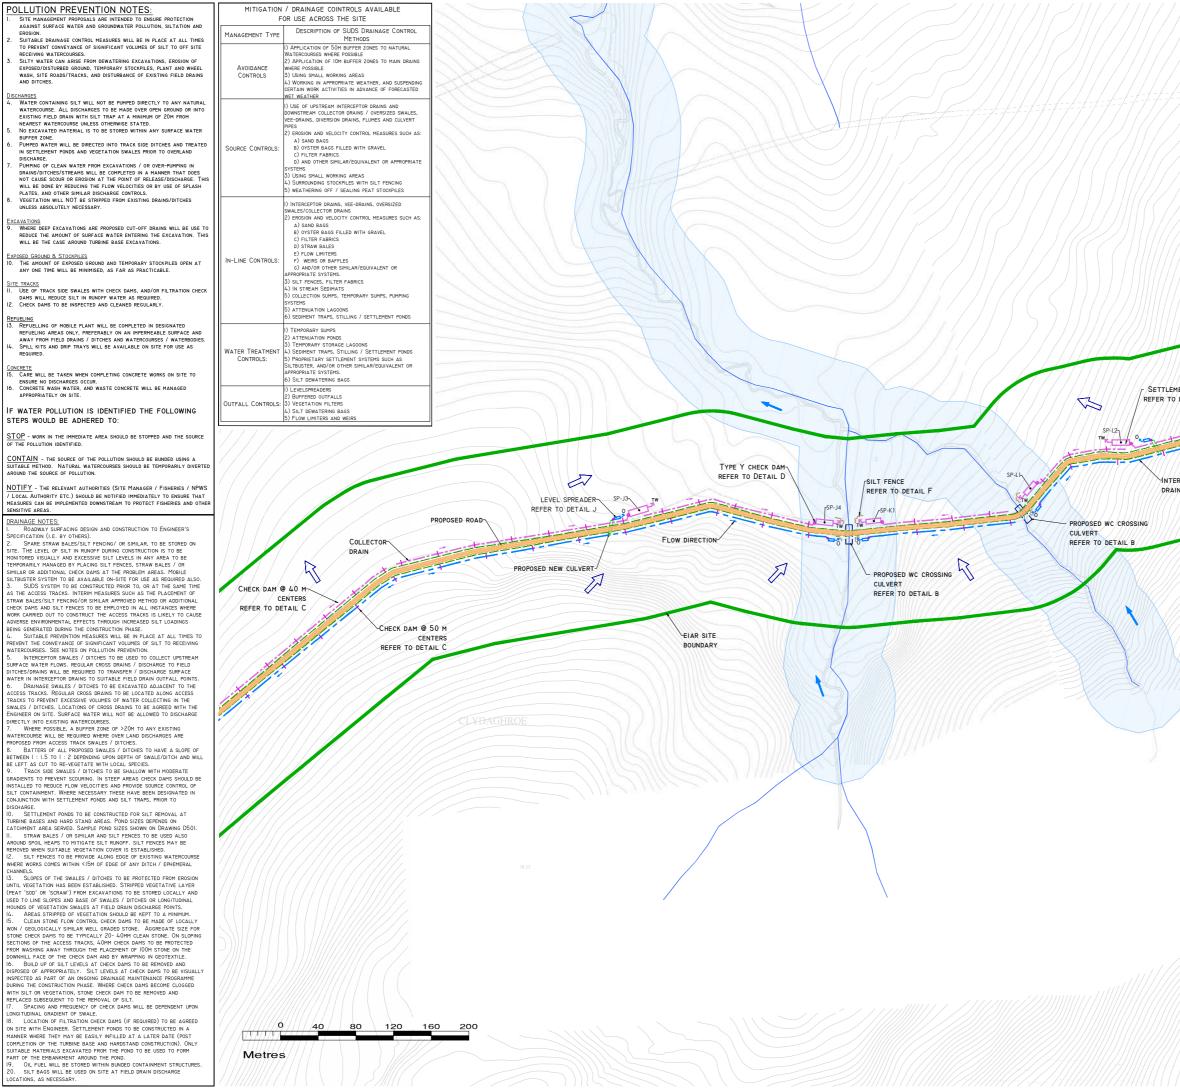

	DRAWING LEGEND :
N	RIVERS/STREAMS
	RIVERS/STREAMS 50M BUFFER
	LAKE 50M BUFFER
	UPSTREAM INTERCEPTOR DRAIN* SWALES/DOWNSTREAM COLLECTOR DRAIN
7-1-1	
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